

EERING SULTING PROJECT MC Fax:

is drawing may be used for the express prose of constructing the work shown the site and owner specified for the te. Any other use of this drawing claim or alteration of the drawing without the prior written proval of Gaskins Surveying Company,


ncluding any reproduction or alteration of his drawing without the prior written pproval of Gaskins Surveying Company, nc. is prohibited.

> KE ROAD SION 331, 332, 389, & 390

SUBDIVISION
17TH DISTRICT, LAND LOTS 331, 33


SHEET TITLE

TREE SURVEY PLAN

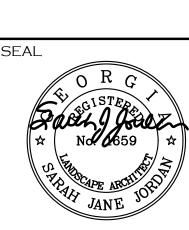

		Н
ROJECT I.D. 805047	FIELD BOOK N/A	
RAWN BY SJJ	CHECKED BY SJJ	
SCALE 1" = 50'	ISSUE DATE 09/14/18	
SHEET NI IMBER		

SHEET NUMBER

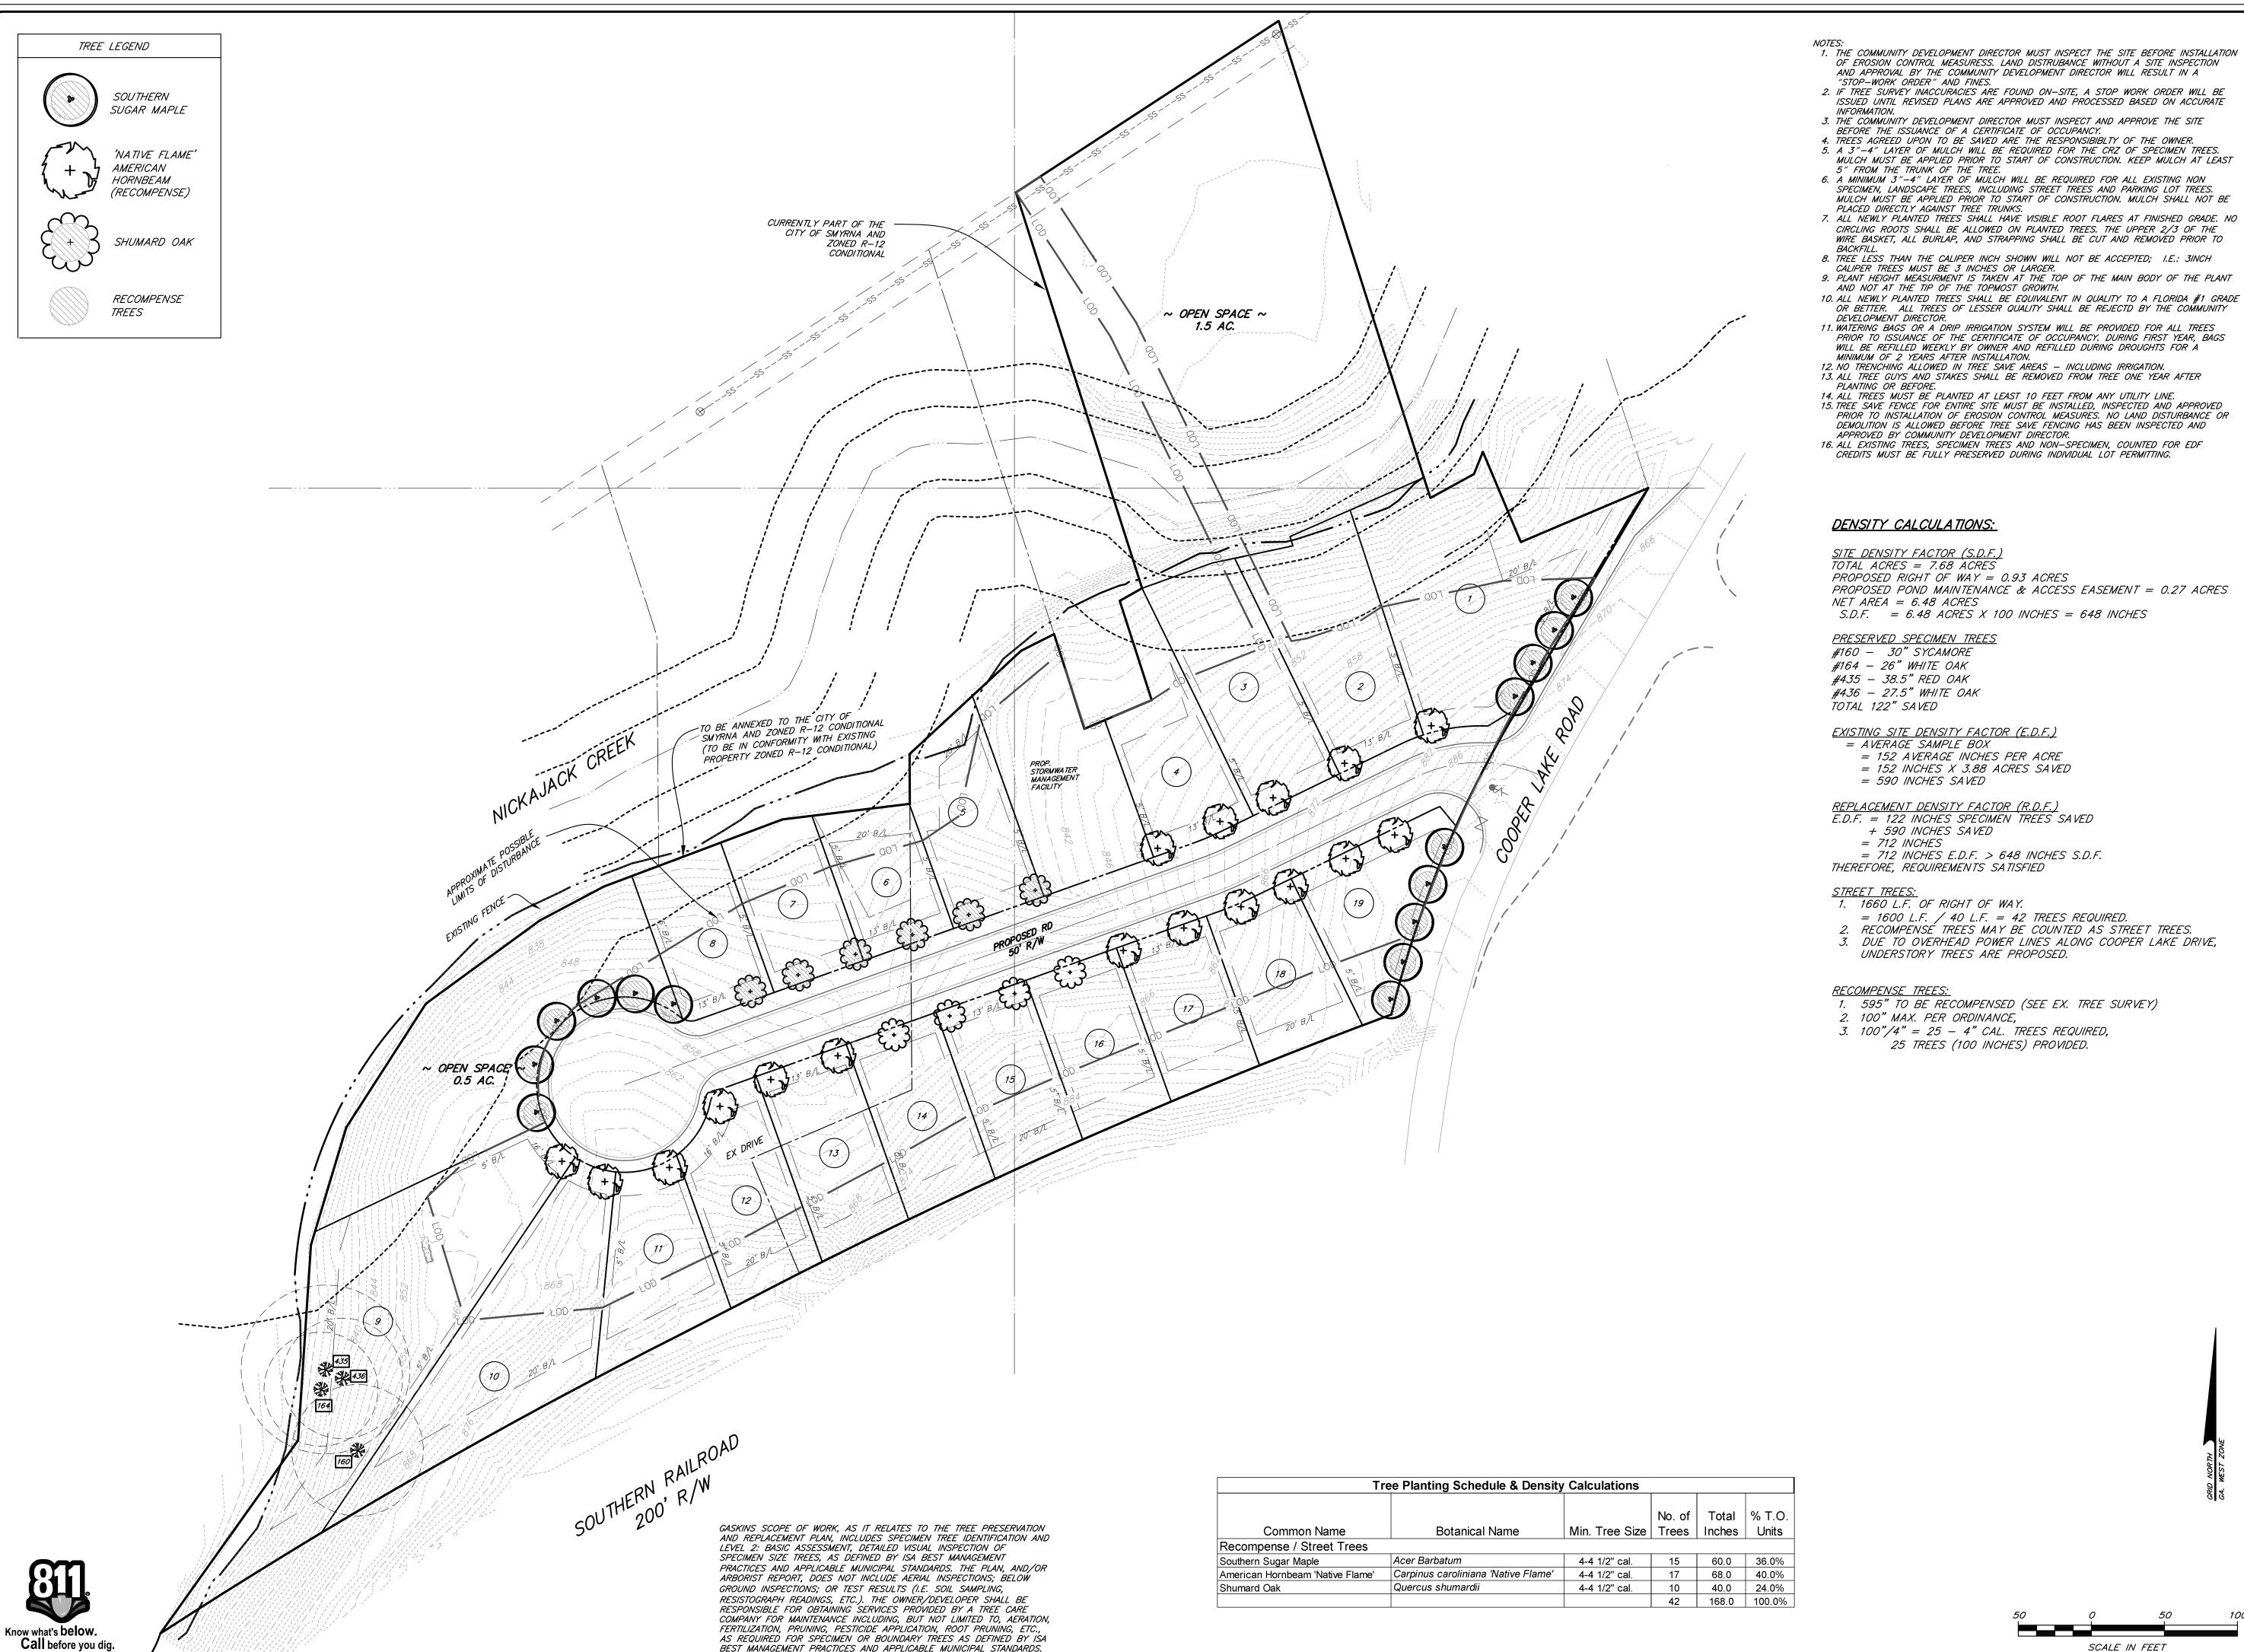

1. THE COMMUNITY DEVELOPMENT DIRECTOR MUST INSPECT THE SITE BEFORE INSTALLATION OF EROSION CONTROL MEASURESS. LAND DISTRUBANCE WITHOUT A SITE INSPECTION AND APPROVAL BY THE COMMUNITY DEVELOPMENT DIRECTOR WILL RESULT IN A

"STOP-WORK ORDER" AND FINES.

2. IF TREE SURVEY INACCURACIES ARE FOUND ON-SITE, A STOP WORK ORDER WILL BE ISSUED UNTIL REVISED PLANS ARE APPROVED AND PROCESSED BASED ON ACCURATE

3. THE COMMUNITY DEVELOPMENT DIRECTOR MUST INSPECT AND APPROVE THE SITE

BEFORE THE ISSUANCE OF A CERTIFICATE OF OCCUPANCY. 4. TREES AGREED UPON TO BE SAVED ARE THE RESPONSIBIBLTY OF THE OWNER.

5. A 3"-4" LAYER OF MULCH WILL BE REQUIRED FOR THE CRZ OF SPECIMEN TREES. MULCH MUST BE APPLIED PRIOR TO START OF CONSTRUCTION. KEEP MULCH AT LEAST 5" FROM THE TRUNK OF THE TREE.

6. A MINIMUM 3"-4" LAYER OF MULCH WILL BE REQUIRED FOR ALL EXISTING NON SPECIMEN, LANDSCAPE TREES, INCLUDING STREET TREES AND PARKING LOT TREES. MULCH MUST BE APPLIED PRIOR TO START OF CONSTRUCTION. MULCH SHALL NOT BE

PLACED DIRECTLY AGAINST TREE TRUNKS. 7. ALL NEWLY PLANTED TREES SHALL HAVE VISIBLE ROOT FLARES AT FINISHED GRADE. NO CIRCLING ROOTS SHALL BE ALLOWED ON PLANTED TREES. THE UPPER 2/3 OF THE WIRE BASKET, ALL BURLAP, AND STRAPPING SHALL BE CUT AND REMOVED PRIOR TO

8. TREE LESS THAN THE CALIPER INCH SHOWN WILL NOT BE ACCEPTED; I.E.: 3INCH CALIPER TREES MUST BE 3 INCHES OR LARGER.

9. PLANT HEIGHT MEASURMENT IS TAKEN AT THE TOP OF THE MAIN BODY OF THE PLANT AND NOT AT THE TIP OF THE TOPMOST GROWTH.

OR BETTER. ALL TREES OF LESSER QUALITY SHALL BE REJECTD BY THE COMMUNITY 11. WATERING BAGS OR A DRIP IRRIGATION SYSTEM WILL BE PROVIDED FOR ALL TREES

PRIOR TO ISSUANCE OF THE CERTIFICATE OF OCCUPANCY. DURING FIRST YEAR, BAGS WILL BE REFILLED WEEKLY BY OWNER AND REFILLED DURING DROUGHTS FOR A MINIMUM OF 2 YEARS AFTER INSTALLATION. 12. NO TRENCHING ALLOWED IN TREE SAVE AREAS - INCLUDING IRRIGATION.

13. ALL TREE GUYS AND STAKES SHALL BE REMOVED FROM TREE ONE YEAR AFTER PLANTING OR BEFORE. 14. ALL TREES MUST BE PLANTED AT LEAST 10 FEET FROM ANY UTILITY LINE.

15. TREE SAVE FENCE FOR ENTIRE SITE MUST BE INSTALLED, INSPECTED AND APPROVED PRIOR TO INSTALLATION OF EROSION CONTROL MEASURES. NO LAND DISTURBANCE OR DEMOLITION IS ALLOWED BEFORE TREE SAVE FENCING HAS BEEN INSPECTED AND APPROVED BY COMMUNITY DEVELOPMENT DIRECTOR.

16. ALL EXISTING TREES, SPECIMEN TREES AND NON-SPECIMEN, COUNTED FOR EDF CREDITS MUST BE FULLY PRESERVED DURING INDIVIDUAL LOT PERMITTING.

DENSITY CALCULATIONS:

SITE DENSITY FACTOR (S.D.F.) TOTAL ACRES = 7.68 ACRES PROPOSED RIGHT OF WAY = 0.93 ACRES PROPOSED POND MAINTENANCE & ACCESS EASEMENT = 0.27 ACRES NET AREA = 6.48 ACRES

PRESERVED SPECIMEN TREES

#164 - 26" WHITE OAK #435 - 38.5" RED OAK #436 - 27.5" WHITE OAK TOTAL 122" SAVED

EXISTING SITE DENSITY FACTOR (E.D.F.) = AVERAGE SAMPLE BOX

= 152 AVERAGE INCHES PER ACRE = 152 INCHES X 3.88 ACRES SAVED

= 590 INCHES SAVED

REPLACEMENT DENSITY FACTOR (R.D.F.) E.D.F. = 122 INCHES SPECIMEN TREES SAVED + 590 INCHES SAVED

= 712 INCHES = 712 INCHES E.D.F. > 648 INCHES S.D.F. THEREFORE, REQUIREMENTS SATISFIED

STREET TREES: 1. 1660 L.F. OF RIGHT OF WAY.

= 1600 L.F. / 40 L.F. = 42 TREES REQUIRED. 2. RECOMPENSÉ TREES MAY BE COUNTED AS STREET TREES. 3. DUE TO OVERHEAD POWER LINES ALONG COOPER LAKE DRIVE, UNDERSTORY TREES ARE PROPOSED.

SCALE IN FEET

RECOMPENSE TREES:

1. 595" TO BE RECOMPENSED (SEE EX. TREE SURVEY)

2. 100" MAX. PER ORDINANCE,

3. 100"/4" = 25 - 4" CAL. TREES REQUIRED, 25 TREES (100 INCHES) PROVIDED.

REVISIONS v. | date | revision reference

s drawing may be used for the express urpose of constructing the work shown or the site and owner specified for the


te. Any other use of this drawing

this drawing without the prior written

approval of Gaskins Surveying Company, Inc. is prohibited.

SHEET TITLE

TREE REPLACEMENT

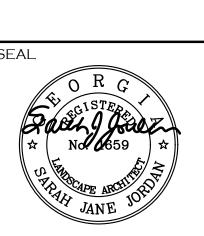

PROJECT I.D.	FIELD BOOK
1805047	N/A
DRAWN BY SJJ	CHECKED BY SJJ
SCALE 1" = 50'	ISSUE DATE 09/14/18