

FEMA Map

N.T.S.

Location Map N.T.S.

Site Notes:

- THE SITE CONTAINS: 0.345 ACRES 15.058 SF
- CURRENT STREET ADDRESS: 1601 WALKER STREET, SMYRNA, GA 30080.
- THE NORTH ARROW AND SCALE ARE SHOWN ON THIS PLAN
- SURVEY INFORMATION TAKEN FROM SURVEYS PERFORMED BY SURVEY LAND EXPRESS DATED FEB 28 2018.

- LAND EXPRESS DATED FEB 28 2018.

 5. NO PORTIONS OF THIS PROPERTY ARE INSIDE DESIGNATED F.E.M.A. SPECIAL FLOOD HAZARD AREA AS PER THE FLOOD INSURANCE RATE MAP #13067C0119 H, DATED MARCH 4, 2013.

 6. THERE ARE NO WATERS OF THE STATE OF GEORGIA (LAKES OR STREAMS) WITHIN 200 FEET OF THE SITE. ALL APPROPRIATE STATE WATER BUFFERS ARE SHOWN ON THE SITE PLANS. THERE ARE NO PROPOSED IMPACTS TO ANY STATE WATER BUFFERS.

 7. TO THE BEST OF OUR KNOWLEDGE, THERE NO CEMETERIES, ARCHITECTURAL, OR ARCHEOLOGICAL LANDWARKS EAST ON SITE. IN THE EVENT THAT THESE LANDWARKS ARE DISCOVERED DURING CONSTRUCTION, THE ENGINEER MUST BE CONTACTED IMMEDIATELY FOR REVIEW AND AMENDING THE CONSTRUCTION PLANS.
- ALL KNOWN UTILITY EASEMENTS PER THE SURVEY ARE SHOWN ON THIS PLAN
- SANITARY SEWER WILL BE PROVIDED TO THE NEW HOUSE THROUGH AN EXISTING CLEANOUT CONNECTION TO COBB COUNTY SEWER SYSTEM. A NEW SEWER LATERAL WILL BE INSTALLED FOR THE SECOND HOUSE. NO ONSITE SEPTIC SYSTEM IS PROPOSED.

RAD Conditional Zoning:

CURRENT ZONING: SINGLE FAMILY ATTACHED OR DETACHED MINIMUM LOT AREA

ATTACHED:
DETACHED:
MINIMUM FLOOR AREA:
MAXIMUM LOT COVERAGE:

15,000 SF (VARIANCE REQUESTED) 1800 SF 45% 100 FEET (VARIANCE REQUESTED)

MINIMUM LOT WIDTH AT FRONT SETBACK: 100 FI
MINIMUM FRONT YARD SETBACK FROM RIGHT OF WAY
MAJOR THOROUGHFARE 75 FT

MINOR THOROUGHFARE 40 FT (VARIANCE REQUESTED) MINIMUM SIDE YARD 35 FT (VARIANCE REQUESTED) MINIMUM REAR YARD MAXIMUM HEIGHT: 40 FT (VARIANCE REQUESTED)

City of Smyrna Site Notes:

- ALL WORK SHALL COMPLY WITH CITY OF SMYRNA DESIGN AND CONSTRUCTION STANDARDS.

 ALL CURRED ISLANDS SHALL BE FILED TO TOP OF CURB WITH TOPSOIL AND GRASSED OR STABILIZED IN ACCORDANCE WITH THE APPROVED LANDSCAPE PLAN.

 ALL OPEN DRAINAGE SWALES MUST BE GRASSED, AND RIPRAP MUST BE PLACED AS REQUIRED TO CONTROL EROSION.

 NO ADDITIONAL DRAINAGE AREAS SHALL BE DIVERTED ONTO CITY RIGHT—OF—WAY.

 ALL CORRUCATED METALL STORM DRAINPIPE SHALL BE FULLY BITUMINOUS—COATED GALVANIZED STEEL OR ALUMINIZED TYPE II WITH RE—ROLLED ENDS AND BANDS.

 HDPE PIPE SHALL BE BEDDED IN ACCORDANCE WITH MANUFACTURER RECOMMENDATIONS.

 APPLICANT SHALL RE—GRASS TO GEORGIA DOT SPECIFICATIONS ALL CITY RIGHT—OF—WAY AREAS THAT ARE DAMAGED OR DISTURBED DURING WORK AUTHORIZED HEREIN.

 ALL HANDICAP RAMPS SHALL BE A MINIMUM OF 3.0' IN WIDTH AND AT A MAXIMUM 12:1 SLOPE.
- · A FIVE (5) FOOT WIDE SIDEWALK IS REQUIRED ALONG ALL PUBLIC STREETS, AND IN SOME
- CASES 10' WIDE, WITH A 2-FOOT GRASS STRIP ADJACENT TO THE BACK OF CURB

 ALL ROAD AND STORM STRUCTURES SHALL CONFORM TO GEORGIA DEPARTMENT OF
 TRANSPORTATION OR COBB COUNTY STANDARD SPECIFICATIONS AND DETAILS
- CONSTRUCTION WITHIN 300 OF RESIDENTIAL OCCUPANCES WILL BE ALLOWED WEEKDAYS BETWEEN THE HOURS OF 7:00 AM AND 6:00 PM, AND SATURDAY FROM 9:00 AM TO 5:00
- P.M.

 LANE CLOSURES ON ARTERIALS ARE PERMITTED ONLY BETWEEN 9:00 AM AND 4:00 P.M.

 PARKING FOR CONSTRUCTION ACTIVITIES SHALL BE PROVIDED ON SITE, OFF OF THE
- RIGHT-UP-MAI.
 FLAGGERS AND TRAFFIC CONTROL WILL BE PROVIDED AT ALL TIMES OF LANE CLOSURE ON ALL ROADS, INCLUDING THE LOADING AND UNLOADING OF EQUIPMENT.

 SANITARY SEWER AND WATER LINES MUST PASS INSPECTION BEFORE STREETS CAN BE DALED.
- BUILDER SHALL BE RESPONSIBLE FOR INSTALLATION OF SIDEWALKS AND THE C.O. WILL NOT BE ISSUED UNTIL SIDEWALK IS INSPECTED AND ACCEPTED.

 ALL EXTERIOR LIGHTING SHALL BE PLACED SO AS NOT TO DIRECTLY ILLUMINATE ADJACENT DEPOSED

- THE OWNER/DEVELOPER IS RESPONSIBLE TO COORDINATE WITH THE US ARMY CORPS OF ENGINEERS CONCERNING PERMITS OR REQUIREMENTS WHEN WETLANDS ARE PROPOSED TO BE DISTURBED ON THE PROPERTY. FAILURE TO REQUEST A DETERMINATION OF PERMIT REQUIREMENT BEFORE DISTURBING ANY WETLANDS COULD RESULT IN PENALTIES BEING INPOSED BY THE CORPS OF ENGINEERS.
- REQUIREMENT BEFORE DISTURBING ANY WETLANDS COULD RESULT IN PENALTIES BEING IMPOSED BY THE CORPS OF ENGINEERS.

 THE OWNER/DEVELOPER IS RESPONSIBLE TO COORDINATE WITH THE GEORGIA DNR EPD CONCERNING PERMITS OR REQUIREMENTS WHEN BUFFERS ARE PROPOSED TO BE DISTURBED ON THE PROPERTY. FAILURE TO REQUEST A DETERMINATION OF PERMIT REQUIREMENT BEFORE DISTURBING ANY BUFFERS COULD RESULT IN DELAY OF PROJECT AND PENALTIES BEING MIPOSED, AND RESTORATION OF BUFFER BEING REQUIRED.

 BURIAL OF CONSTRUCTION MATERIALS IS NOT PERMITTED WITHIN THE CITY OF SMYRNA.

 BURNING OF DEBRIS OR CONSTRUCTION MATERIALS IS NOT PERMITTED WITHIN THE CITY OF SMYRNA.
- SM INNA.

 AS-BUILT PLANS OF ALL STORMWATER MANAGEMENT FACILITIES SHALL BE PROVIDED TO THE CITY OF SWYRIA PRIOR TO THE ISSUANCE OF THE FINAL PLAT. AS-BUILT PLANS SHALL BE CERTIFIED BY A PROFESSIONAL ENGINEER.

 ALL SILT BARRIERS AND CONSTRUCTION ENTRANCE PADS MUST BE PLACED PRIOR TO ANY
- CLEARING AND/OR GRADING. NO GRADING SHALL BE DONE UNTIL SILT BARRIER INSTALLATION
- IS COMPLETE.

 A "SEVEN-DAY" LETTER SHALL BE PREPARED BY THE DESIGN ENGINEER STATING THE SITE IS
 IN COMPLIANCE WITH THE APPROVED E&S PLAN PRIOR TO PROCEEDING WITH MASS GRADING OPERATIONS

- OPERATIONS

 THE CONSTRUCTION PAD SHALL BE MAINTAINED IN A CONDITION THAT WILL PREVENT TRACKING OR FLOW OF MUD ONTO PUBLIC STREETS.

 SILT FENCES AND BARRIERS SHALL BE CLEANED OR REPLACED AND MAINTAINED IN FUNCTIONAL CONDITION UNTIL PERMANENT EROSION CONTROL MEASURES ARE ESTABLISHED. ALL CRASSING SHALL BE IN ACCORDANCE WITH THE MANUAL FOR EROSION AND SEDIMENT CONTROL IN GEORGIA, LATEST EDITION.

 ALL OTHER WORK SHALL BE PERFORMED IN ACCORDANCE WITH THE SPECIFICATIONS OF THIS SAME MAINTAIL
- TEMPORARY VEGETATION AND/OR HEAVY MULCH WILL BE USED TO STABILIZE AREAS. IN NO CASE SHALL A SITE BE LEFT BARE FOR MORE THAN SEVEN (7) DAYS.
- ALL DISTURBED AREAS WILL BE PERMANENTLY LANDSCAPED AND GRASSED AS SOON AS
- PRACTICABLE.

 ADDITIONAL MEASURES MAY BE REQUIRED TO CONTROL EROSION AS DETERMINED NECESSARY
- BY CITY INSPECTORS.

 EROSION CONTROL BLANKETS SHALL BE USED ON ALL SLOPES EXCEEDING 3:1 OVER 5 VERTICAL FEET IN HEIGHT

 ALL APPLICATIONS OF HYDROSEED WILL BE FOLLOWED BY ½" TO 1" MULCH.

 NO CLEARING BEYOND THE LIMITS OF DISTURBANCE SHOWN ON THE APPROVED PLANS SHALL BE ALLOWED.
- NO CLEARING BEYOND THE LIMITS OF DISTURBANCE SHOWN ON THE APPROVED PLANS SHALL
 BE ALLOWED.
 NO LAND DISTURBING ACTIVITY WITHIN ANY TREE SAVE AREA SHALL BE ALLOWED.
 NOTICE IS HEREBY GIVEN THAT ALL EROSION AND SEDIMENT DEVICES AND PRACTICES MUST
 BE INSTALLED AND MAINTAINED AT ALL TIMES. NO FURTHER NOTICE WILL BE GIVEN. ANY SITE
 UPON WHICH THE LAND DEVELOPMENT INSPECTOR FINDS ANY DEFICIENCY WILL BE SUBJECT
 TO AN IMMEDIATE ENFORCEMENT ACTION WITHOUT WARNING.
- FROSION AND SEDIMENT CONTROL DEVICES MUST BE MAINTAINED IN A SATISFACTORY CONDITION 24 HOURS A DAY, 7 DAYS A WEEK.

 IT IS THE RESPONSIBILITY OF THE CONTRACTOR TO OBTAIN QUALIFIED PROFESSIONAL ADVICE WHEN QUESTIONS ARISE CONCERNING DESIGN AND EFFECTIVENESS OF EROSION CONTROL DEVICES.
- WHEN QUESTIONS ARISE CONCERNING DESIGN AND EFFECTIVENESS OF EROSION CONTROL DEVICES.

 EROSION CONTROL DEVICES THAT ARE INSTALLED AS DIRECTED OR ALLOWED BY CITY INSPECTORS BUT NOT SHOWN ON THE APPROVED PLAN AND WHICH ALSO SUBSEQUENTLY FAIL, ARE THE RESPONSIBILITY OF THE CONTRACTOR. THE CITY OF SMYRNA ASSUMES NO RESPONSIBILITY OR LIABILITY FOR DIRECTION PROVIDED BY CITY STAFF DURING INSPECTIONS. ALL TEMPORARY AND PERMANENT SEEDING MUST BE PERFORMED AT THE APPROPRIATE SEASON. ADDITIONAL PLANTINGS WILL BE NECESSARY IF A SUFFICIENT STAND OF GRASS FAILS TO GROW.

 1 THE CITY INSPECTOR WILL DETERMINE ADEQUATE COVER OF NEW PLANTINGS.

 1 OPSOIL SHALL BE STOCKPILED AND USED TO DRESS FINAL GRADES.

 NO DISTURBANCE WILL BE ALLOWED WITHIN FLOOD PLANS OR WETLANDS WITHOUT APPROPRIATE PERMITS.

 SILT FENCES SHALL NOT BE PLACED IN STREAM BUFFER OR FLOOD PLANS.

 NO CERTIFICATES OF OCCUPANCY WILL BE ISSUED UNTIL TO THE INSPECTION AND MAINTENANCE AGREEMENT IS RECORDED.

- MAINTENANCE AGREEMENT IS RECORDED MAINTEMANUE AUMERMENT TO RECURDED

 TREE PROTECTION FENCE SHALL BE SHOWN ON THE EROSION CONTROL PLAN

 STATE AND CITY UNDISTURBED STREAM BUFFERS SHALL BE FLAGGED/MARKED IN THE FIELD

Lot Coverage:

2,223 SQ.FT. 313 SQ.FT. 25 SQ.FT. PROPOSED PATIO + ENTRY PORCH PROPOSED WALLS + A/C PAD 25 SQ.FT. 552 SQ.FT. 3,113 SQ.FT. PROPOSED WALKWAY + DRIVEWAY TOTAL IMPERVIOUS AREA TOTAL LOT AREA LOT COVERAGE

PROPOSED HOUSE PROPOSED PATIO + ENTRY PORCH PROPOSED WALLS + A/C PAD
PROPOSED WALLWAY + DRIVEWAY
TOTAL IMPERVIOUS AREA
TOTAL LOT AREA

LOT B:

1062.00 "RBF 1060.00 N 85°38'20"E 1/2"RBF N 85°38'20"E 49.94 1 INFILTRATION TRENCH #1
C-3 20'X12'X3.5' TOP ELEV = 1060.00 INFILTRATION TRENCH #2 1 20'X12'X3.5' C-3 1062.00 TW=1073.00 TOP ELEV = 1060.00 BW=1068.10 TW=1073.00 BW=1068.00 4' CRASS FILTER STRIP LIMITS OF DISTURBANCE · GRASS FILTER STRIP TW=10 BW=1068.05 Prepared For Matt Junger 60 Palisades Rd Allania, GA 30309 1064.00 1070.20 BW=1068.0 1072.95 LOT B LOT A 1601 WALKER ST 601 WALKER ST 40 00 PROPOSED **PROPOSED** 1072.95 068.00 HOUSE 40! HOUSE PATIC 4 -ÓT AREA = 7,495 SF OT AREA = 7,593 SF FFE = 1073.00 FFE = 1073.00TW=1073.00 GFFE = 1071.00 GFFE = 1072.00 10 BW=1070.0 BFFE = 1063.50 BFFE = 1063.50 00 1070.35 Plan 00 1070.45 \bigcirc 1070.45 TW=1073.00 BW=1070.25 97 Site 101 1069.50 EXISTING WATER METER
TO BE RELOCATED TO PORCH PORCH 2 CAR GARAGE THE RIGHT OF THE PROPOSED DRIVEWAY 1069.80 2 CAR GARAGE THE RIGHT OF THE PROPOSED DRIVEWAY 1071.95 PROPOSED PROPOSED 307.90' ALONG R/W DRIVEWAY TO R/W OF MATHEWS ST 15'BLS Street istrict orgia 图图 Construction Plan.

Walker S

... at 593 17th Distr ≫ 1069.00 -00-BC/BC/VARIES 盟 09 2,223 SQ.FT. 312 SQ.FT. 26 SQ.FT. EXISTING UTILITIES TO BE RELOCATED AND TO BE USED FOR NEW CONSTRUCTIONS CVE PI# 18-285 GRAPHIC SCALE 7,495 SQ.FT. 41.40% Sheet No. ,=

24 HOUR EMERGENCY CONTACT: MATT JUNGER 404-493-1555



- 1. THE CONSTRUCTION PAD SHALL BE MAINTAINED IN A CONDITION WHICH WILL PREVENT TRACKING OR FLOW OF MUD ONTO PUBLIC STREETS.
- 2. SILT FENCES AND HAY BALE BARRIERS SHALL BE CLEANED OR REPLACED AND MAINTAINED IN FUNCTIONAL CONDITION UNTIL PERMANENT EROSION CONTROL MEASURES ARE ESTABLISHED.
- ALL WORK SHALL BE PERFORMED IN ACCORDANCE WITH THE SPECIFICATION OF THE MANUAL FOR EROSION
 AND SEDIMENT CONTROL IN GEORGIA.
- . THE CONTRACTOR SHALL CLEAN OUT ALL ACCUMULATED SILT FROM THE SEDIMENT PONDS ONCE ALL DISTURBED AREAS ARE STABILIZED WITH PERMANENT VEGETATION.
- 5. EROSION CONTROL DEVICES WILL BE IN PLACE BEFORE SITE DISTURBANCE AND WILL BE PERIODICALLY INSPECTED AND REPAIRED OR RESTORED AS NEEDED TO FUNCTION PROPERLY UNTIL PERMANENT MEASURES ARE ESTABLISHED AND PROJECT IS COMPLETE, I.E.: CONSTRUCTION EXITS AND SILT FENCES SHALL BE RETOPPED OR CLEANED AS SILT REDUCES THEIR AFFECTIVENESS.
- 6. ANY ADDITIONAL CONSTRUCTION OTHER THAN SHOWN ON THIS PLAN WILL REQUIRE SEPARATE AND ADDITIONAL EROSION AND SEDIMENT CONTROL MEASURES AND APPROVAL.
- TEMPORARY VEGETATION AND/OR HEAVY MULCH WILL BE USED TO STABILIZE AREAS. IN NO CASE SHALL A SITE BE LEFT BARE FOR MORE THAN 14 DAYS.
- 8. ALL DISTURBED AREAS WILL BE PERMANENTLY LANDSCAPED AND GRASSED AS SOON AS CONSTRUCTION PHASES PERMIT
- 9. ADDITIONAL MEASURES MAY BE REQUIRED TO CONTROL EROSION AS DETERMINED NECESSARY BY
- 10. PERSON RESPONSIBLE FOR EROSION CONTROL MEASURES IS: 24 HOUR EMERGENCY CONTACT: PHILIP JUNGER 404-909-6912
- 11. CUT AND FILL SLOPES NOT TO EXCEED 2H: 1V.
- 12. SEDIMENTATION & EROSION CONTROL MEASURES TO BE INSPECTED DAILY.
- 12. SEDIMENTATION & ENCIRCU CONTROL MEASURES TO BE INSPECTED DAILT.

 13. ADDITIONAL MEASURES MAY BE REQUIRED TO CONTROL EROSION AS DETERMINED NECESSARY BY INSPECTORS. THE EROSION CONTROL MEASURE CAN BE DESIGNED BY A LEVEL 1B (BLUE CARD) GASWCC CERTIFIED CONTRACTOR, UNLESS THE BMP HAS A HYDRAULIC COMPONENT. FOR ALL BMP DESIGN MITH A HYDRAULIC COMPONENT, THE BMP MUST BE DESIGNED BY A LEVEL 2 (GOLD CARD) GASWCC CERTIFIED DESIGNER. A CONSTRUCTION EXIT IS NOT PROPOSED DUE TO THE SMALL SIZE OF THE PROJECT AND THE LEVEL 1B CONTRACTOR MUST PROVIDE ALL MEASURES TO PREVENT ANY SILT FROM ENTERING THE STREAM.

SILT FENCE PROVIDED = 440 LINEAR FEET SEDIMENT STORAGE REQUIRED = 17.74 CU YD SEDIMENT STORAGE PROVIDED = 22.00 CU YD

City of Smyrna Landscape Notes:

- ALL TREES MUST BE PLANTED AT LEAST 10' FROM ANY UTILITY LINE.
 THE COMMUNITY DEVELOPMENT DIRECTOR MUST INSPECT AND APPROVE THE SITE BEFORE THE ISSUANCE OF A CERTIFICATE
 OF OCCUPANCY.
- OF OCCUPANCY.

 A 3" LAYER OF ORGANIC MULCH WILL BE REQUIRED FOR ALL REPLACEMENT TREES. MULCH MUST BE APPLIED PRIOR TO START OF CONSTRUCTION. MULCH SHALL NOT BE PLACED DIRECTLY AGAINST TREE TRUNKS.

 ALL NEWLY PLANTED TREES SHALL HAVE MISIBLE ROOT FLARES AT FINISHED GRADE. NO CIRCLING ROOTS SHALL BE ALLOWED ON PLANTED TREES. THE UPPER 2/3 OF THE WIRE BASKET, ALL BURLAP, AND STRAPPING SHALL BE CUT AND REMOVED PRIOR TO BACKFILL

 TREES LESS THAN THE CALIPER INCH SHOWN WILL NOT BE ACCEPTED. I.E.: 4 INCH CALIPER TREES MUST BE 4 INCHES OR LARGER.
- LARGER.
 PLANT HEIGHT MEASUREMENT IS TAKEN AT THE TOP OF THE MAIN BODY OF THE PLANT AND NOT AT THE TIP OF THE
- PLANT HEIGHT MEASUREMENT IS TAKEN AT THE TOP OF THE MAIN BODY OF THE PLANT AND NOT AT THE TIP UP THE TOPMOST GROWTH.

 ALL NEMY, PLANTED TREES SHALL BE EQUIVALENT IN QUALITY TO A FLORIDA #1 GRADE OR BETTER. ALL TREES OF LESSER QUALITY SHALL BE REJECTED BY THE COMMUNITY DEVELOPMENT DIRECTOR.

 WATERING BAGS OR A DRIP IRRIGATION SYSTEM WILL BE PROVIDED FOR ALL TREES PRIOR TO ISSUANCE OF THE CERTIFICATE OF OCCUPANCY. DURING FIRST YEAR BAGS WILL BE REFILLED WEEKLY BY OWNER AND REFILLED DURING DROUGHTS FOR A MINIMUM OF 2 YEARS AFTER INSTALLATION.

 NO TRENCHING ALLOWED IN TREE SAYE AREAS—INCLIDING IRRIGATION.

 3. ALL TREE CUYING AND STAKES SHALL BE REMOVED FROM TREE ONE YEAR AFTER PLANTING DATE.


 1. EVERY NEW COMMERCIAL OR INSTITUTIONAL DEVELOPMENT SHALL PLANT AND MAINTAIN A BED OF JONQUILS OR OTHER APPROPRIATE FLOWERS AT A LOCATION VISIBLE FROM A PUBLIC RIGHT—OF—WAY.

Tree Save/Density Requirement

DENSITY REQUIREMENT: REQUIRED DENSITY IS 100" PER ACRE)

REQUIRED DENSITY (100" X 0.17) = 17" REQUIRED

REQUIRED DENSITY (100" X 0.17) = 17" REQUIRED PROVIDED DENSITY = 31'
REQUIREMENT MET

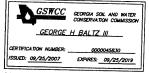

THE ESCAPE OF SEDIMENT FROM THE SITE SHALL BE PREVENTED BY THE INSTALLATION OF EROSION AND SEDIMENT CONTROL MEASURES AND PRACTICES PRIOR TO, OR CONCURRENT WITH,

EROSION CONTROL MEASURES WILL BE MAINTAINED AT ALL TIMES. IF FULL IMPLEMENTATION OF THE APPROVED PLAN DOES NOT PROVIDE FOR EFFECTIVE EROSION CONTROL, ADDITIONAL EROSION AND SEDIMENT CONTROL MEASURES SHALL BE PROVIDED BY THE CONTRACTOR FOR EFFECTIVE EROSION IMPLEMENTED TO CONTROL OR TREAT THE SEDIMENT SOURCE.

ANY DISTURBED AREAS LEFT EXPOSED FOR A PERIOD GREATER THAN 14 DAYS SHALL BE STABILIZED WITH MULCH OR TEMPORARY SEEDING.

ANY DISTURBED AREAS REMAINING IDLE FOR 30 DAYS SHALL BE STABILIZED WITH PERMANENT

State Waters Notes:

NO PORTIONS OF THIS PROPERTY ARE INSIDE DESIGNATED F.E.M.A. SPECIAL FLOOD HAZARD AREA AS PER THE FLOOD INSURANCE RATE MAP #13067C0129 H, DATED MARCH 4, 2013.

THERE ARE NO WATERS OF THE STATE OF GEORGIA (LAKES OR STREAMS WITHIN 200 FEET OF THE SITE. ALL APPROPRIATE STATE WATER BUFFERS ARE SHOWN ON THE SITE PLANS. THERE ARE NO PROPOSED IMPACTS TO ANY STATE WATER BUFFERS.

Soil Legend:

MgB2 - MADISON SANDY LOAM, 2 TO 6 PERCENT SLOPES, ERODED MgC2 - MADISON SANDY LOAM, 6 TO 10 PERCENT SLOPES, ERODED

Tree To Remain Onsite:

	LOT A	
DIAMETER	TREE	AREA
19	PINE	ONSITE
otal Inches (DBH) To	Remain = 19	

	LOT B	
DIAMETER	TREE	AREA
9	HARDWOOD	ONSITE
7	HARDWOOD	ONSITE
15 I Inches (DBH)	PINE	ONSITE


Tree Lost/Destroyed:

	LOT A	
DBH	TREE	AREA
25	HARDWOOD	ONSITE
13	HARDWOOD	ONSITE
16	HARDWOOD	ONSITE
17	HARDWOOD	ONSITE
9	HARDWOOD	ONSITE
12	PINE	ONSITE
6	HARDWOOD	ONSITE
12	HARDWOOD	ONSITE
6	HARDWOOD	ONSITE
16	PINE	ONSITE
20	PINE	ONSITE
8	PINE	ONSITE

LOT B				
DBH	TREE	AREA		
20	HARDWOOD	ONSITE		
22	HARDWOOD	ONSITE		
21	HARDWOOD	ONSITE		
24	HARDWOOD	ONSITE		
23	HARDWOOD	ONSITE		
10	HARDWOOD	ONSITE		
18	HARDWOOD	ONSITE		
17	HARDWOOD	ONSITE		
7	HARDWOOD	ONSITE		
16	HARDWOOD	ONSITE		
17	PINE	ONSITE		
25	PINE	ONSITE		
20	PINE	ONSITE		
11	HARDWOOD	ONSITE		
6	HARDWOOD	ONSITE		
22	HARDWOOD	ONSITE		
9	HARDWOOD	ONSITE		
13	PINE	ONSITE		
12	PINE Removed = 313	ONSITE		

Total Trees Removed ≈ 1 **: DEAD TREE REMOVE



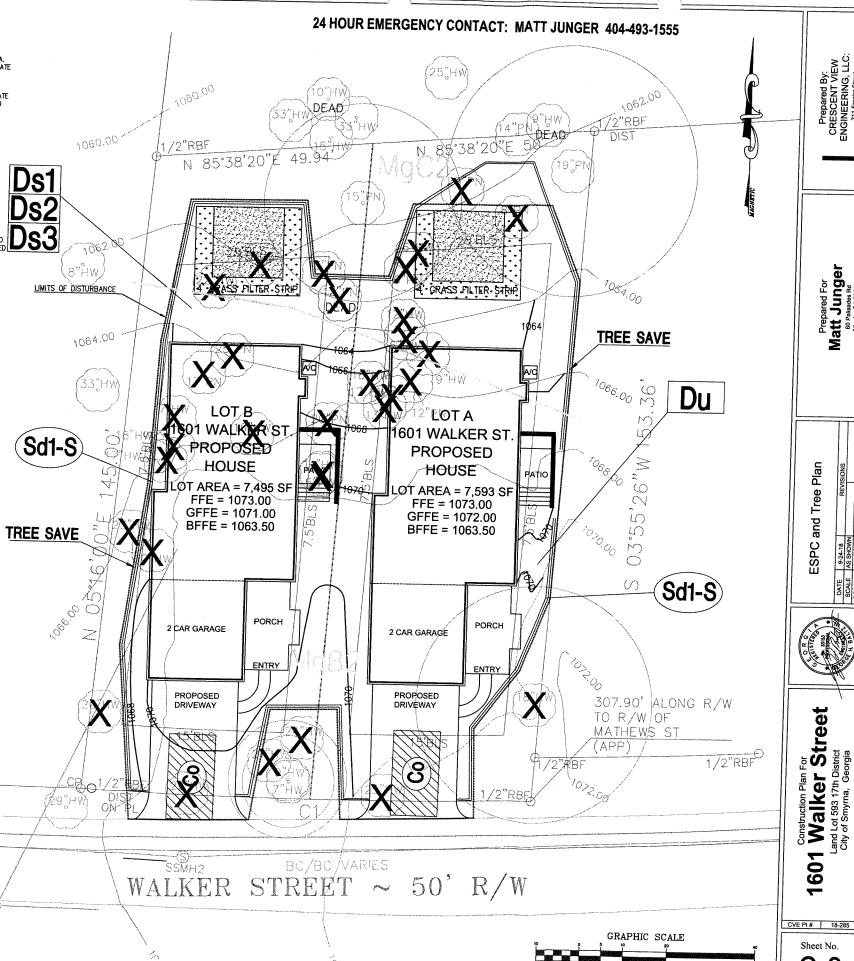


Prepared For Matt Junger 60 Palisades Rd Atlanta, GA 30309

Plan

et

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601

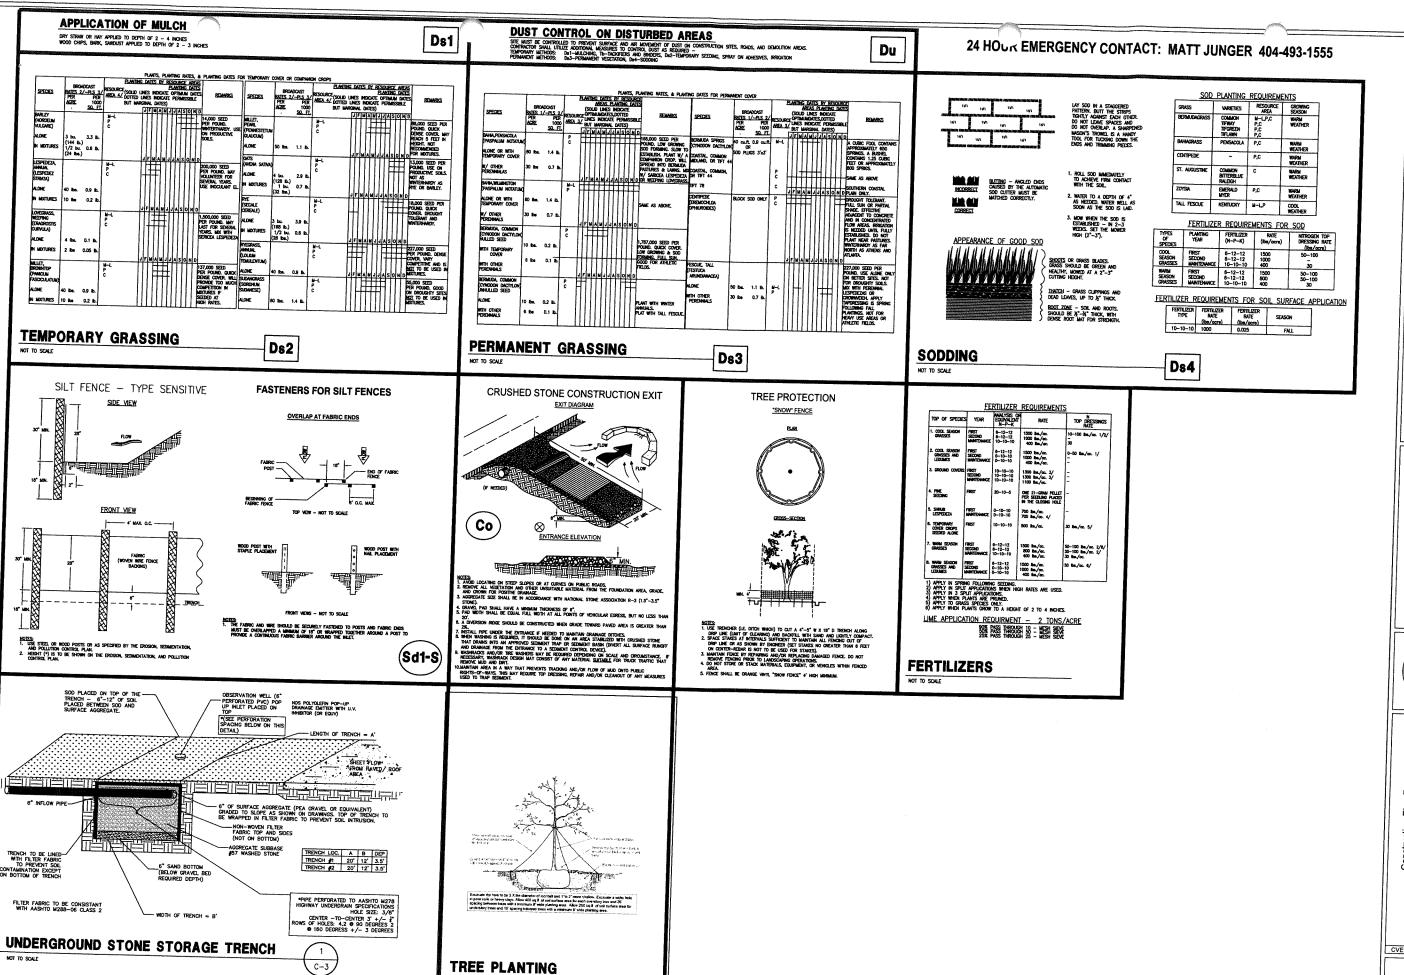

TREE PLANTING

Prepared For Matt Junge

DETAILS



et Stree Construction Plan F

1601

CVE PI # 18-285

Sheet No. **U-**

Existing Trees on Site

2 1 1 1 2	6 6 7	Hardwood Pine	0			
1 1	7	Pine		12	remove	No
1		11114	0	6	remove	No
		Hardwood	0	7	remove	No
2	8	Pine	0	8	remove	No
	9	Hardwood	0	18	remove	No
11	10	Hardwood	0	10	remove	No
1	11	Hardwood	0	11	remove	No
1	12	Hardwood	0	12	remove	No
2	12	Pine	0	24	remove	No
1	13	Hardwood	0	13	remove	No
1	13	Pine	0	13	remove	No
1	15	Pine	15	0	save	No No
2	16	Hardwood	0	32	remove	No No
2	16	Pine	0	32	remove	No
1	17	Hardwood	0	17	remove	No
2	17	Pine	0	34	remove	No
2	18	Hardwood	0	36	remove	No
1	19	Pine	0	19	remove	No No
2	20	Pine	0	40	remove	No
1	20	Hardwood	0	20		
1	21	Hardwood	0	21	remove	No
2	22	Hardwood	0	44	remove	No
2	23	Hardwood	0	46	remove	No No
1	24	Pine	0	24	remove	No
1	25	Pine	0	25	remove	No
35	**		15	524	remove	No

Boundary Trees

Number	Size (In Inches)	Species	Location	CRZ Impact	Root Plate Impact?	Notes
1	29	Hardwood	SW property corner	16.80%	No	Tree to Remain - ex. Street tree
2	33	Hardwood	West property line	32.30%	Yes	
3	33	Hardwood	North property line	18.60%	No	Tree to Remain- may need arborist presription
4	15	Hardwood	North property line	3.80%	No	Tree to Remain
5	33	Hardwood	North property line	19.52%	No	Tree to Remain
6	25	Hardwood	North property line	4.90%	No	Tree to Remain
				4.30%	ING	Tree to Remain
7	14	Pine	North property line	6.10%	No	Tree to Remain

NOTE:

- A Certified Arborist will be evaluating the current health of the trees. If that report highlights any issues we will update this plan accordingly.

- A tree replacement plan addendum for this project shall be submitted to the community development director at least 30 days prior to requesting a final inspection. This plan shall include the species, size, and location of trees to be planted off-site to meet the tree density deficit shown. Release of this project is
- Inspection. This plant shall include the species, size, and location of these to be planted on-she to meet the use density deficit shown. Release of this plant as well as verification on the installation of the trees.

 The CRZ of Specimen Trees receiving 3X credit shall be protected with 6-foot chain link tree save fencing spaced 6 feet on center with metal support posts and Tree Save signage. Installation of the tree save fence will involve no trenching. 3 Inches of Organic mulch over the CRZ and an above-ground irrigation
- Contact the Community Development Department (770-319-5387) to arrange a pre construction conference prior to any land disturbance. No permit shall be issued until plans are approved and an on-site inspection with city representatives occurs.
- All tree protection measures shall be installed prior to grading or the removal of impervious surfaces or structures.
- Buffers shall be replanted subject to the Community Development Department approval.
- True save fence for the entire site must be installed, inspected, and approved prior to the installation on erosion control measures. No land disturbance or demolition is allowed before tree save fencing has been inspected and approved by the Community Development Director.

 ALL EXISTING TREES, SPECIMEN, AND NON-SPECIMEN, COUNTED FOR EDF CREDITS MUST BE FULLY PRESERVED DURING INDIVIDUAL LOT
- ALL TREES MUST BE PLANTED AT LEAST 10 FEET FROM ANY UTILITY LINE.
 NO TREES SHALL BE PLANTED ON ANY AREA OF EARTHEN DAM OR EMBANKMENT.
- The Community Development Director must inspect the site before the installation of erosion control measures. Land disturbance without a site inspection and approval by the Community Development Director will result in a 'STOP WORK ORDER' and fines.
- If tree survey inaccuracies are found on-site, a stop work order will be issued until revised plans are approved and processed based on accurate
- The Community Development Director must inspect and approve the site before the issuance of a Certificate of Occupancy
- Trees agreed upon to be saved is the responsibility of the owner.
- A 3-Inch layer of organic mulch will be required for the CRZ of Specimen Trees. Mulch must be applied prior to the start of construction. Keep mulch at least 5-inch radius away from trunk.
- All newly planted trees shall have visible root flares at finished grade. No circling roots shall be allowed on planted trees. The upper of the wire basket, all burlap, and strapping shall be cut and removed before the backfilling of planting holes.


 - Trees less than the caliper inch shown will not be accepted. Example: 4-inch caliper trees must be 4-inches or larger.


 - Plant height measurements are taken at the top of the main body of the plant and not at the tip of the topmost growth

- All newly planted trees shall be equivalent in quality to a Florida #1 grade or better. All trees of lesser quality can be rejected by the Community
- Watering bags or a drip irrigation system will be provided or all trees prior to issuance of the certificate of occupancy. Water bags will be refilled according to soil conditions and adjusted during times of drought for a minimum of 2 years after installation - No trenching allowed in Tree Save Area, including irrigation installation. - All tree guying and stakes shall be removed from tree(s) one year after planting date.

NOTE:


- See Sheet TRP-2.0 for Planting Calculation / Breakdowns and Plant Lists.

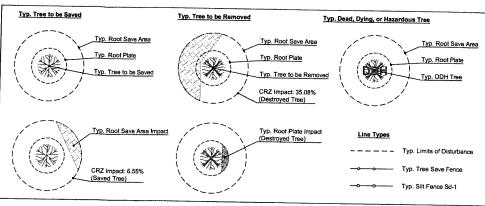

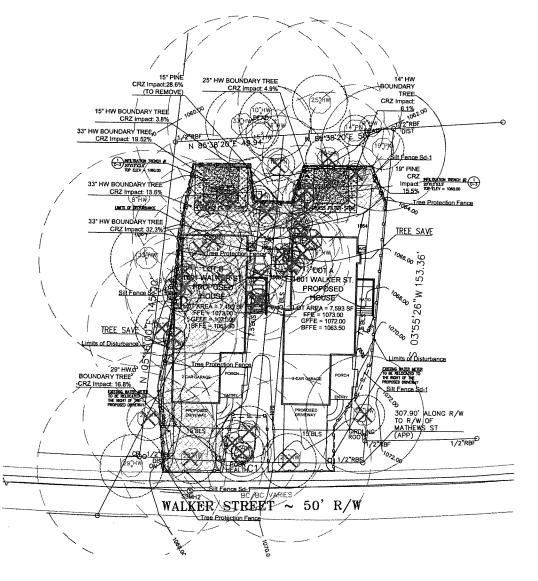






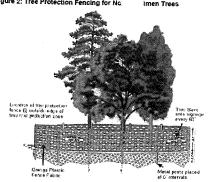


**Specimen tree protection requires orange polyethylene fence be replaced with

TREE PROTECTION FENCE DETAIL

Figure 13: Acceptable Grade Fills Within Root Zone:

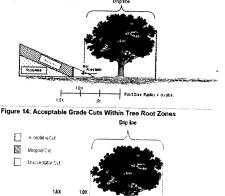


Root Plate - .5" radius per 1" doi Critical Root Zone - 1.5' radius per 1" don. g within Tree Root Zones

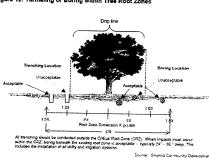

TREE GRADING CUE CARD DETAILS

40

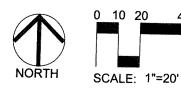

SITE DATA: Land Lot: Current Zoning:

Owner Address: Acreage Site Address:

24 Hour contact:

1601 WALKER Street Smyrna, GA 30080 Matt Junger 404-493-1555

R-20

17th 2nd section,

Cobb County, GA

60 Palisades Rd NE

Atlanta, GA 30309

Junger Homes

DATE DESCRIPTION 2-8-19 FINAL

PLAN EMENT O 1 / REPL, CTION MYRNA, GA 30 ECTIC SMYRNA, P 1 REI MA 9

AND CONSULTING, LLC

678.503.0390-0

PROTECTION / REPLACEMENT PLAN

> SCALE 1"=20'

SHEET NUMBER TRP-1.0

Specimen Recompense Calculations

Specimen Trees Removed					
Quanity	Size	Species	Total Inches		
0	0	na	0		
		Required Specimen			
		Recompense	0		

Recomp	Recompense Trees							
Quantity	Size (Inches)	Common Name	Botanical Name	Total Inches				
0	0	na	na	0				
0				0				

Street Tree Requirements

	1 overstory every 40 Linear Feet of Road, or		
Street Tree Requirement	1 Understory every 30 Linear Feet of Road		
	(If Overhead Utiliies Exist)		
Street Linear Feet	102		
Required Trees on Street	3 Overstory Trees		
Provided Trees on Street	2 Overstory Trees and 1 understory (because of the existing Canopy tree 29° HW, there is no room to plant full Canopy tree. Understory in that vacinity will be best choice and show effor to fufill the stree tree requirment. The other two spaces do not have ample room to suppor more than one canopy tree in each area).		

Density Requirements

Required Caliper Inches per Acre	100
Site Acreage	0.345
Required Caliper Inches for Site	34.5
Existing Inches on Site	15
Required Caliper Inches	19.5
Provided Caliper Inches	21

Quantity	Size (Inches)	Common Name	Botanical Name	Total Inches (Quanitity x Size)
2	4	Chinese Elm	Ulmus parvifolia	9
11	3	Nutall Oak	Quercus nuttallii	3
2	3	Serviceberry	Amelanchier	+ 3 - 1
2	2	Nellie R. Stevens Holly	How Marilia D. Co	<u> </u>
7		remen. Sevens hony	nex Neme R. Stevens'	4

N 85'38'20"E 49.94

Silt Fence Sd

TREE SAVE

2"POT A

601 WALKER ST PROPOSED

HOUSE AREA = 7,593

Quantity	Size (Inches)	Common Name	Botanical Name	Total Inches (Quanitity x Size)	Genus
2	4	Chinese Elm	Ulmus parvifolia	8	28.57%
1	4	Nutali Oak	Quercus nuttallii		
2	3	Serviceberry	Amelanchier		14.29%
2	3	Nellie R. Stevens Holly		- 0	28.57%
7		Henre R. Stevens Hony	nex Neme R. Stevens'	6	28.57%
					100.0



2-8-19

DESCRIPTION

FINAL

PLAN

CEMENT


EPI

区

PROTECTION ERSTREET SMYRNA, GA 3

REE

Figure 11: Tree Planting Detail

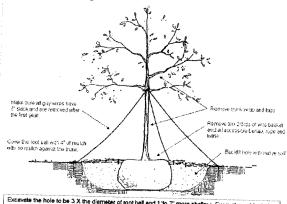

Excavate the hole to be 3 X the diameter of not bell and 1 to 2" more shallow. Excavate a wider hole in poor soils or heavy clays. Allow 400 sq.ft, of soil surface area for each overstory tree and 25" spacing between trees with a minimum 8" wide planting area. Allow 200 sq.ft. of soil surface area for understory trees and 15" spacing between trees with a minimum 8" wide planting area.

NOTE:

- A Certified Arborist will be evaluating the current health of the trees. If that report highlights any issues we will update this plan accordingly.

TREE PLANTING DETAIL

- NOTE:

 A tree replacement plan addendum for this project shall be submitted to the community development director at least 30 days prior to requesting a final inspection. This plan shall include the species, size, and location of frees to be planted off-site to meet the tree density deficit shown. Release of this project is subject to approval of this plan, as well as verification on the installation of the trees.
- Subject to approval or this pilati, as well as verification or the installation of the trees.

 The CRZ of Specimen Trees receiving 3X credit shall be protected with 6-foot chain link tree save fencing spaced 6 feet on center with metal support posts. and Tree Save signage. Installation of the tree save fence will involve no trenching. 3 Inches of Organic mulch over the CRZ and an above-ground irrigation
- Contact the Community Development Department (770-319-5387) to arrange a pre construction conference prior to any land disturbance. No permit shall be issued until plans are approved and an on-site inspection with city representatives occurs.
- All tree protection measures shall be installed prior to grading or the removal of impervious surfaces or structures.
- Buffers shall be replanted subject to the Community Development Department approval.
- Tree save fence for the entire site must be installed, inspected, and approved prior to the installation on erosion control measures. No land disturbance or
- demolition is allowed before tree save fencing has been inspected and approved by the Community Development Director.

 ALL EXISTING TREES, SPECIMEN, AND NON-SPECIMEN, COUNTED FOR EDF CREDITS MUST BE FULLY PRESERVED DURING INDIVIDUAL LOT
- ALL TREES MUST BE PLANTED AT LEAST 10 FEET FROM ANY UTILITY LINE.
- NO TREES SHALL BE PLANTED ON ANY AREA OF EARTHEN DAM OR EMBANKMENT. - The Community Development Director must inspect the site before the installation of erosion control measures. Land disturbance without a site inspection and approval by the Community Development Director will result in a 'STOP WORK ORDER' and fines.
- If tree survey inaccuracies are found on-site, a stop work order will be issued until revised plans are approved and processed based on accurate
- The Community Development Director must inspect and approve the site before the issuance of a Certificate of Occupancy.
- Trees agreed upon to be saved is the responsibility of the owner.
- A 3-Inch layer of organic mulch will be required for the CRZ of Specimen Trees. Mulch must be applied prior to the start of construction. Keep mulch at least
- All newly planted trees shall have visible root flares at finished grade. No circling roots shall be allowed on planted trees. The upper $\frac{4}{3}$ of the wire basket, all -All newly planted trees shall be cut and removed before the backfilling of planting holes.

 - Trees less than the caliper inch shown will not be accepted. Example: 4-inch caliper trees must be 4-inches or larger.

 - Plant height measurements are taken at the top of the main body of the plant and not at the tip of the topmost growth.

- All newly planted trees shall be equivalent in quality to a Florida #1 grade or better. All trees of lesser quality can be rejected by the Community
- Watering bags or a drip irrigation system will be provided or all trees prior to issuance of the certificate of occupancy. Water bags will be refilled according to soil conditions and adjusted during times of drought for a minimum of 2 years after installation.

 No trenching allowed in Tree Save Area, including irrigation installation.
- All tree guying and stakes shall be removed from tree(s) one year after planting date.

PROPOSED TREES


WALKER STREET ~ 50' R/W

SCALE: 1"=20"

307.90' ALONG R/W TO R/W OF

TREE LEGEND Nellie R. Stevens Holly (3" Cal.) Serviceberry (3" Cal.)



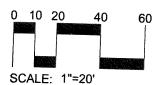

R-20

SITE DATA: District:

Current Zoning: Owner Address:

Site Address:

24 Hour contact:

60 Palisades Rd NE Atlanta, GA 30309 1601 WALKER Street Smyrna, GA 30080 Matt Junger 404-493-1555

17th 2nd section. Cobb County, GA

Junger Homes

AND CONSULTING, LLC

0

SHEET NUMBER TRP-2.0

678.503.0390-0 TREE PROTECTION / REPLACEMENT PLAN SCALE 1"=20'